

ATTACHED 2 STOREY DUAL OCCUPANCY WITH TORRENS SUBDIVISION ON 93 HORSLEY ROAD PANANIA; NSW 2213; LOT 4 DP 31155

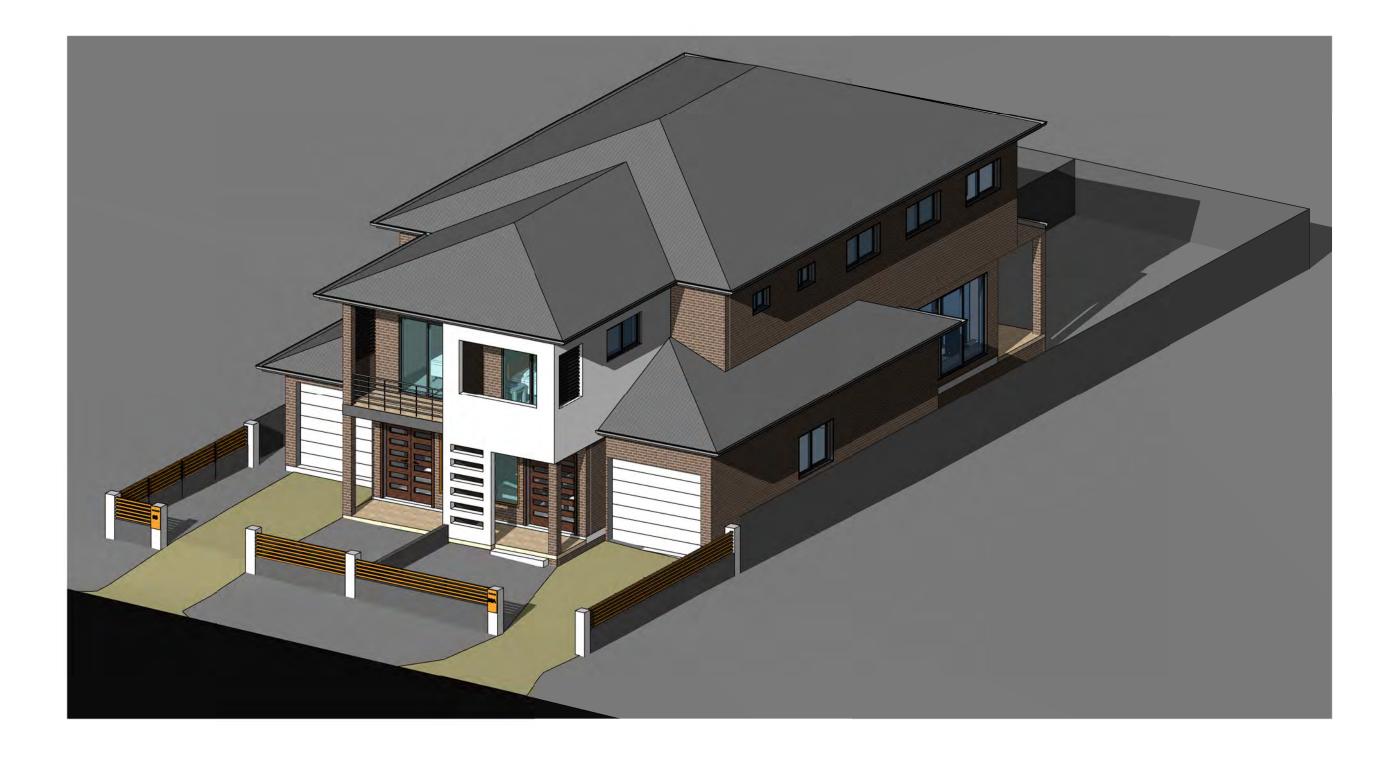

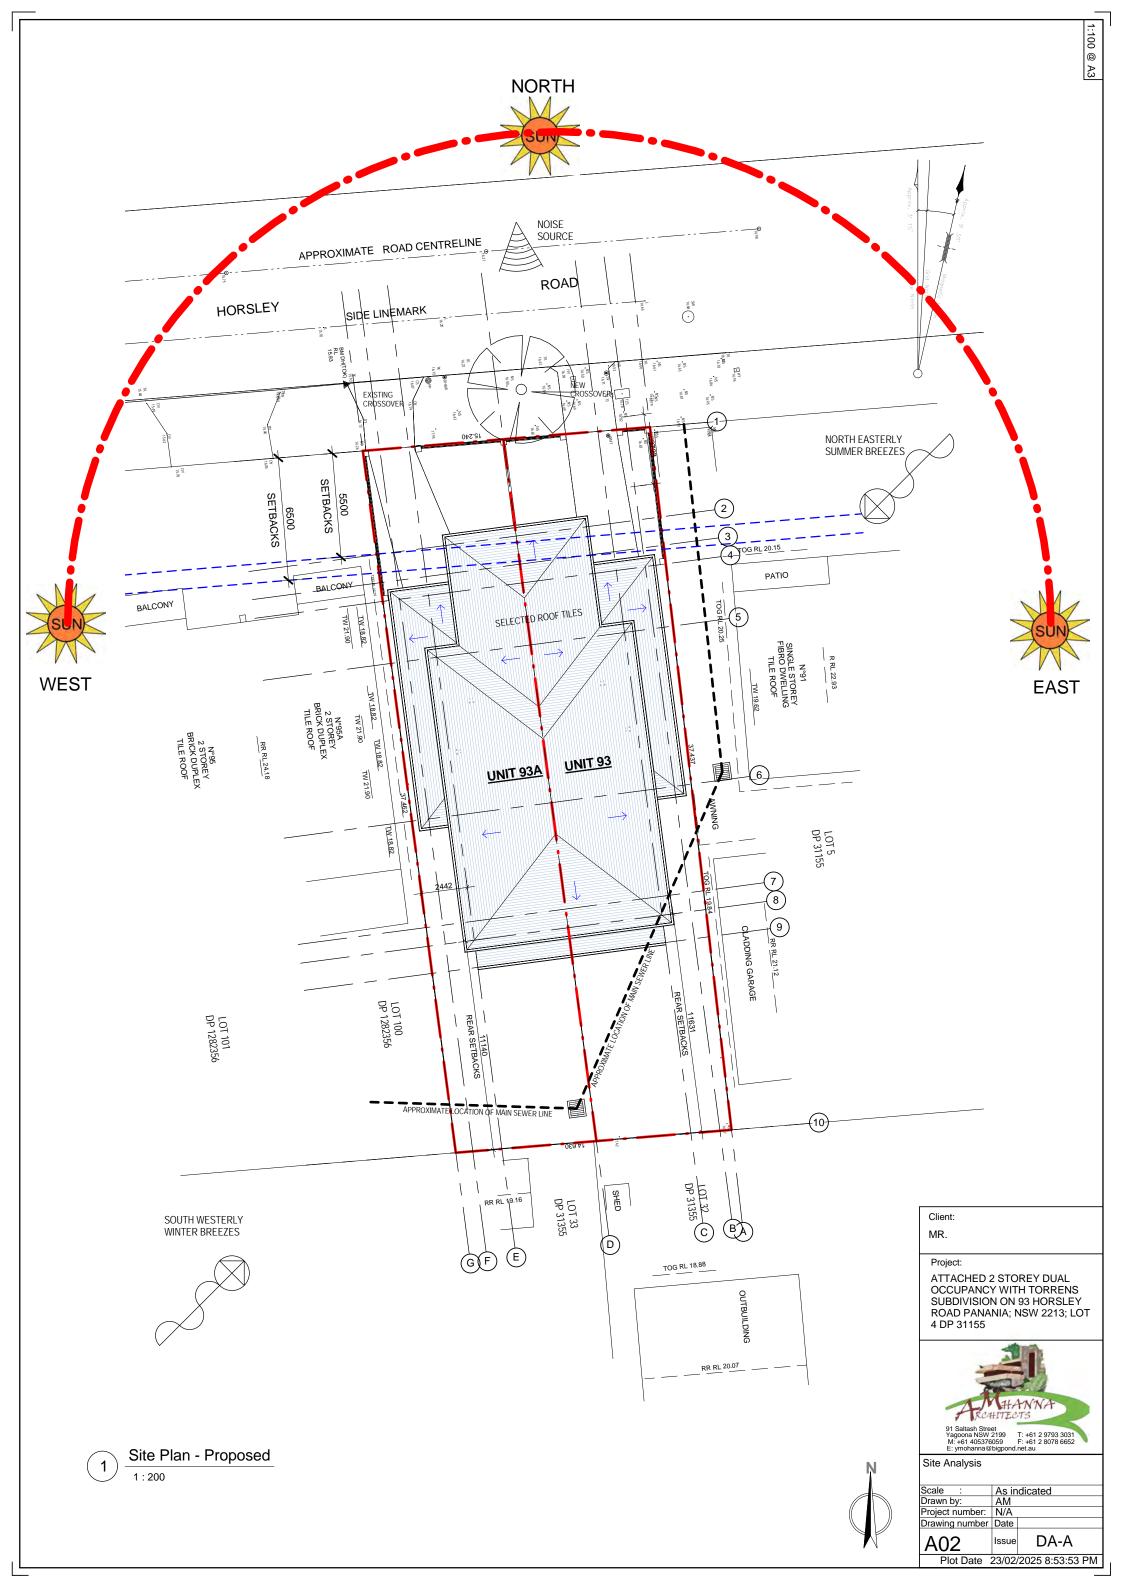




TOTAL LAND AREA = 558.8 SQM

50% = 279.40m2


Proposed: <u>279m2 = 50% FSR</u>

Area Anal	ysis					
Name	Area					
Alfresco	23.98					
Balcony	9.27					
Driveway	44.27					
Landscape	129.50					
Landscape - Unit 93	132.71					
LOT 4A	279.69					
LOT 4B	279.15					
Patio	9.56					
Roof - Unit 93	139.28					
Roof - Unit 93A	139.28					
Unit 93	139.52					
Unit 93A	139.52					

1465.72

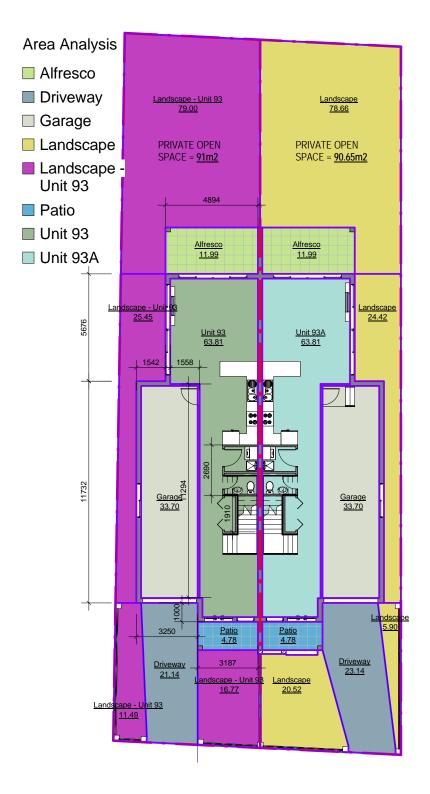



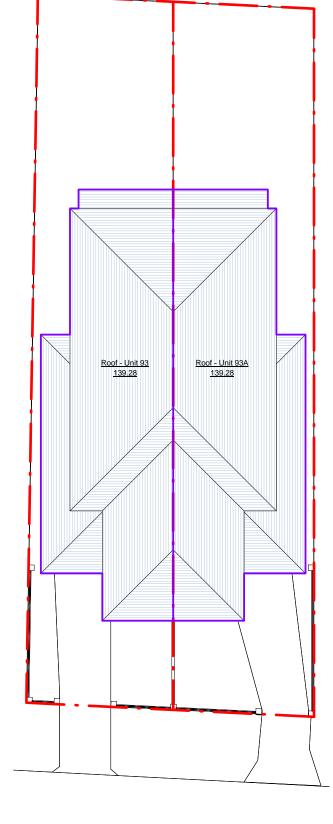



Grand total: 29









Area Analysis	

1:100 @ A1

BASIX COMMITMENTS - UNIT 93 & 93A

<u>Unit 93</u>

-R5.5 insulation to plasterboard ceiling

-R1.3 foil blanket and sisalation underneath metal roof

-Downlights which penetrate the ceiling to be fitted with approved fireproof, non-ventilated covers allowing uninterrupted ceiling insulation

-R2.5 insulation to cantilevered timber first floor

-foil+R2.7 insulation to all brick veneer external walls

-R2.7 insulation to all garage internal walls

-R1.5 insulation under the ground floor slab except the garage

-all windows and sliding doors shall be: Aluminium standard single-glazed: clear glass: U = 6.70 & SHGC = 0.70

-RWT: 1,000L to collect 45sqm of roof area and to be connected to toilets and landscape

-hot water system: 4star gas instantaneous or equivalent

<u>Unit 93A</u>

-R5.5 insulation to plasterboard ceiling

-R1.3 foil blanket and sisalation underneath metal roof

-Downlights which penetrate the ceiling to be fitted with approved fireproof, non-ventilated covers allowing uninterrupted ceiling insulation

-R2.5 insulation to cantilevered timber first floor

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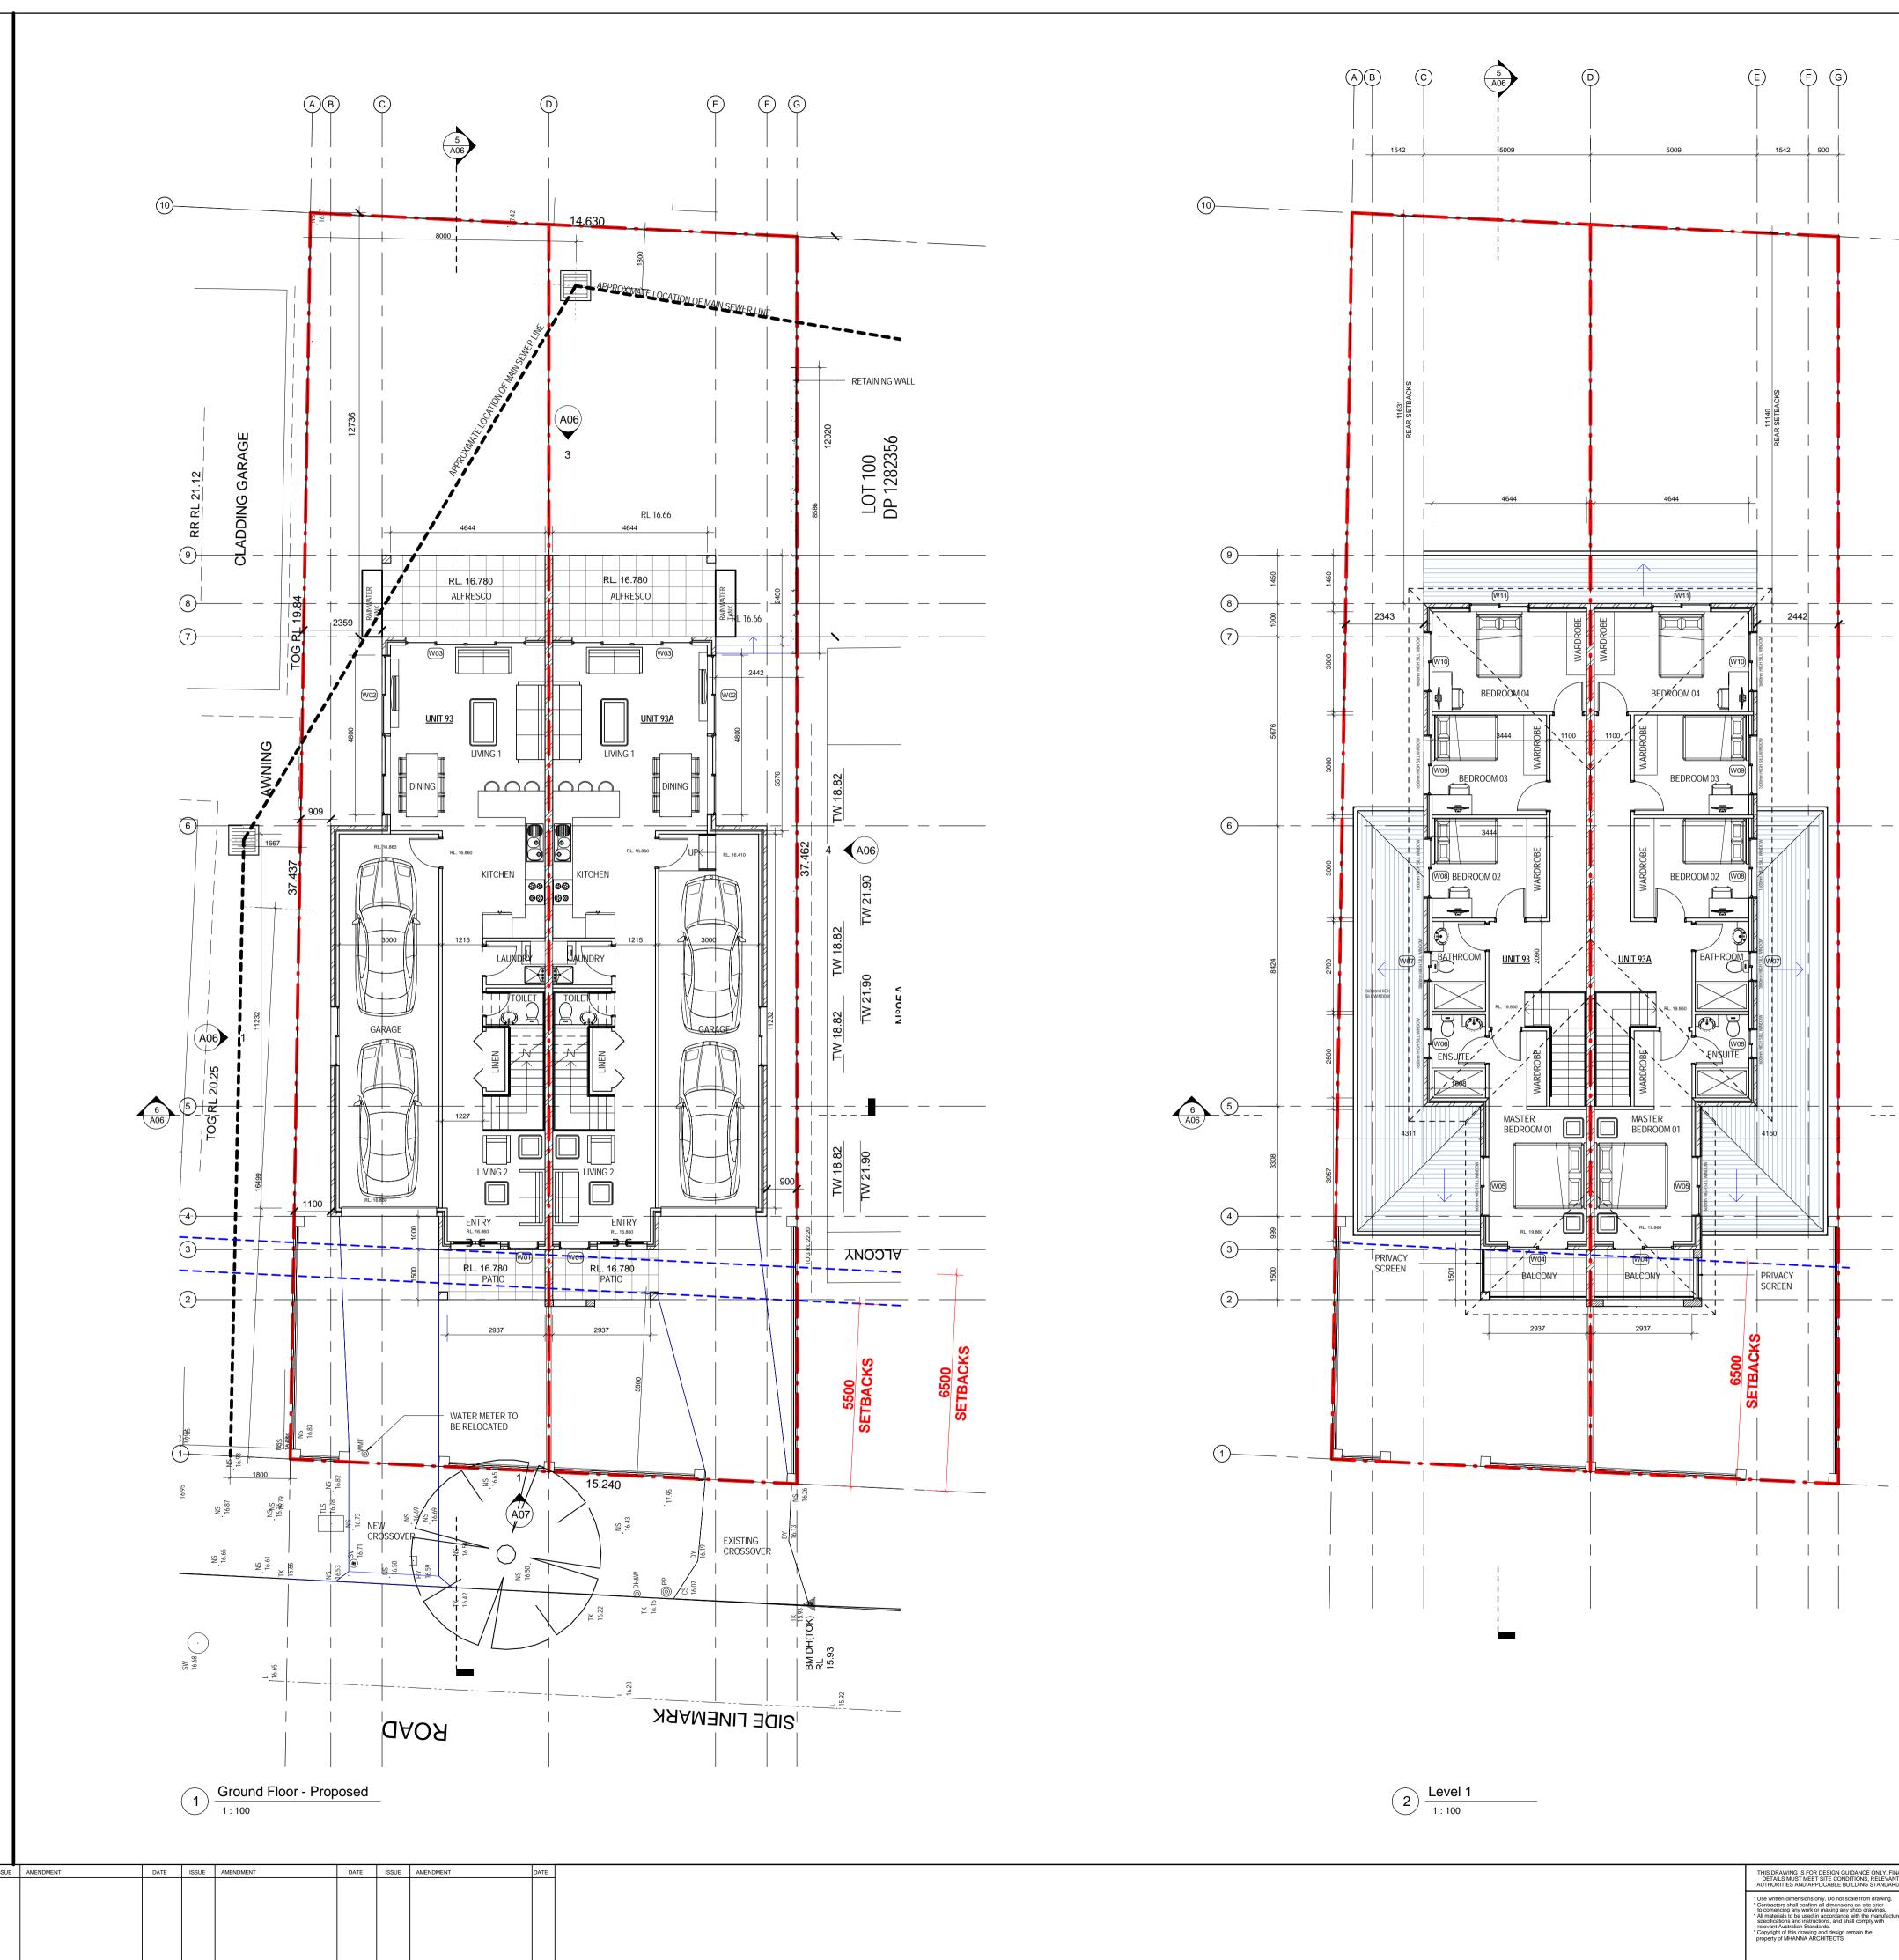
-R1.5 insulation under the ground floor slab except the garage


-all windows and sliding doors shall be: Aluminium standard single-glazed: low-e glass: U = 5.40 & SHGC = 0.58


-RWT: 1,000L to collect 45sqm of roof area and to be connected to toilets and landscape


ATTACHED 2 STOREY DUAL OCCUPANCY WITH TORRENS SUBDIVISION ON 93 HORSLEY ROAD PANANIA; NSW 2213; LOT 4

-hot water system: 4star gas instantaneous or equivalent



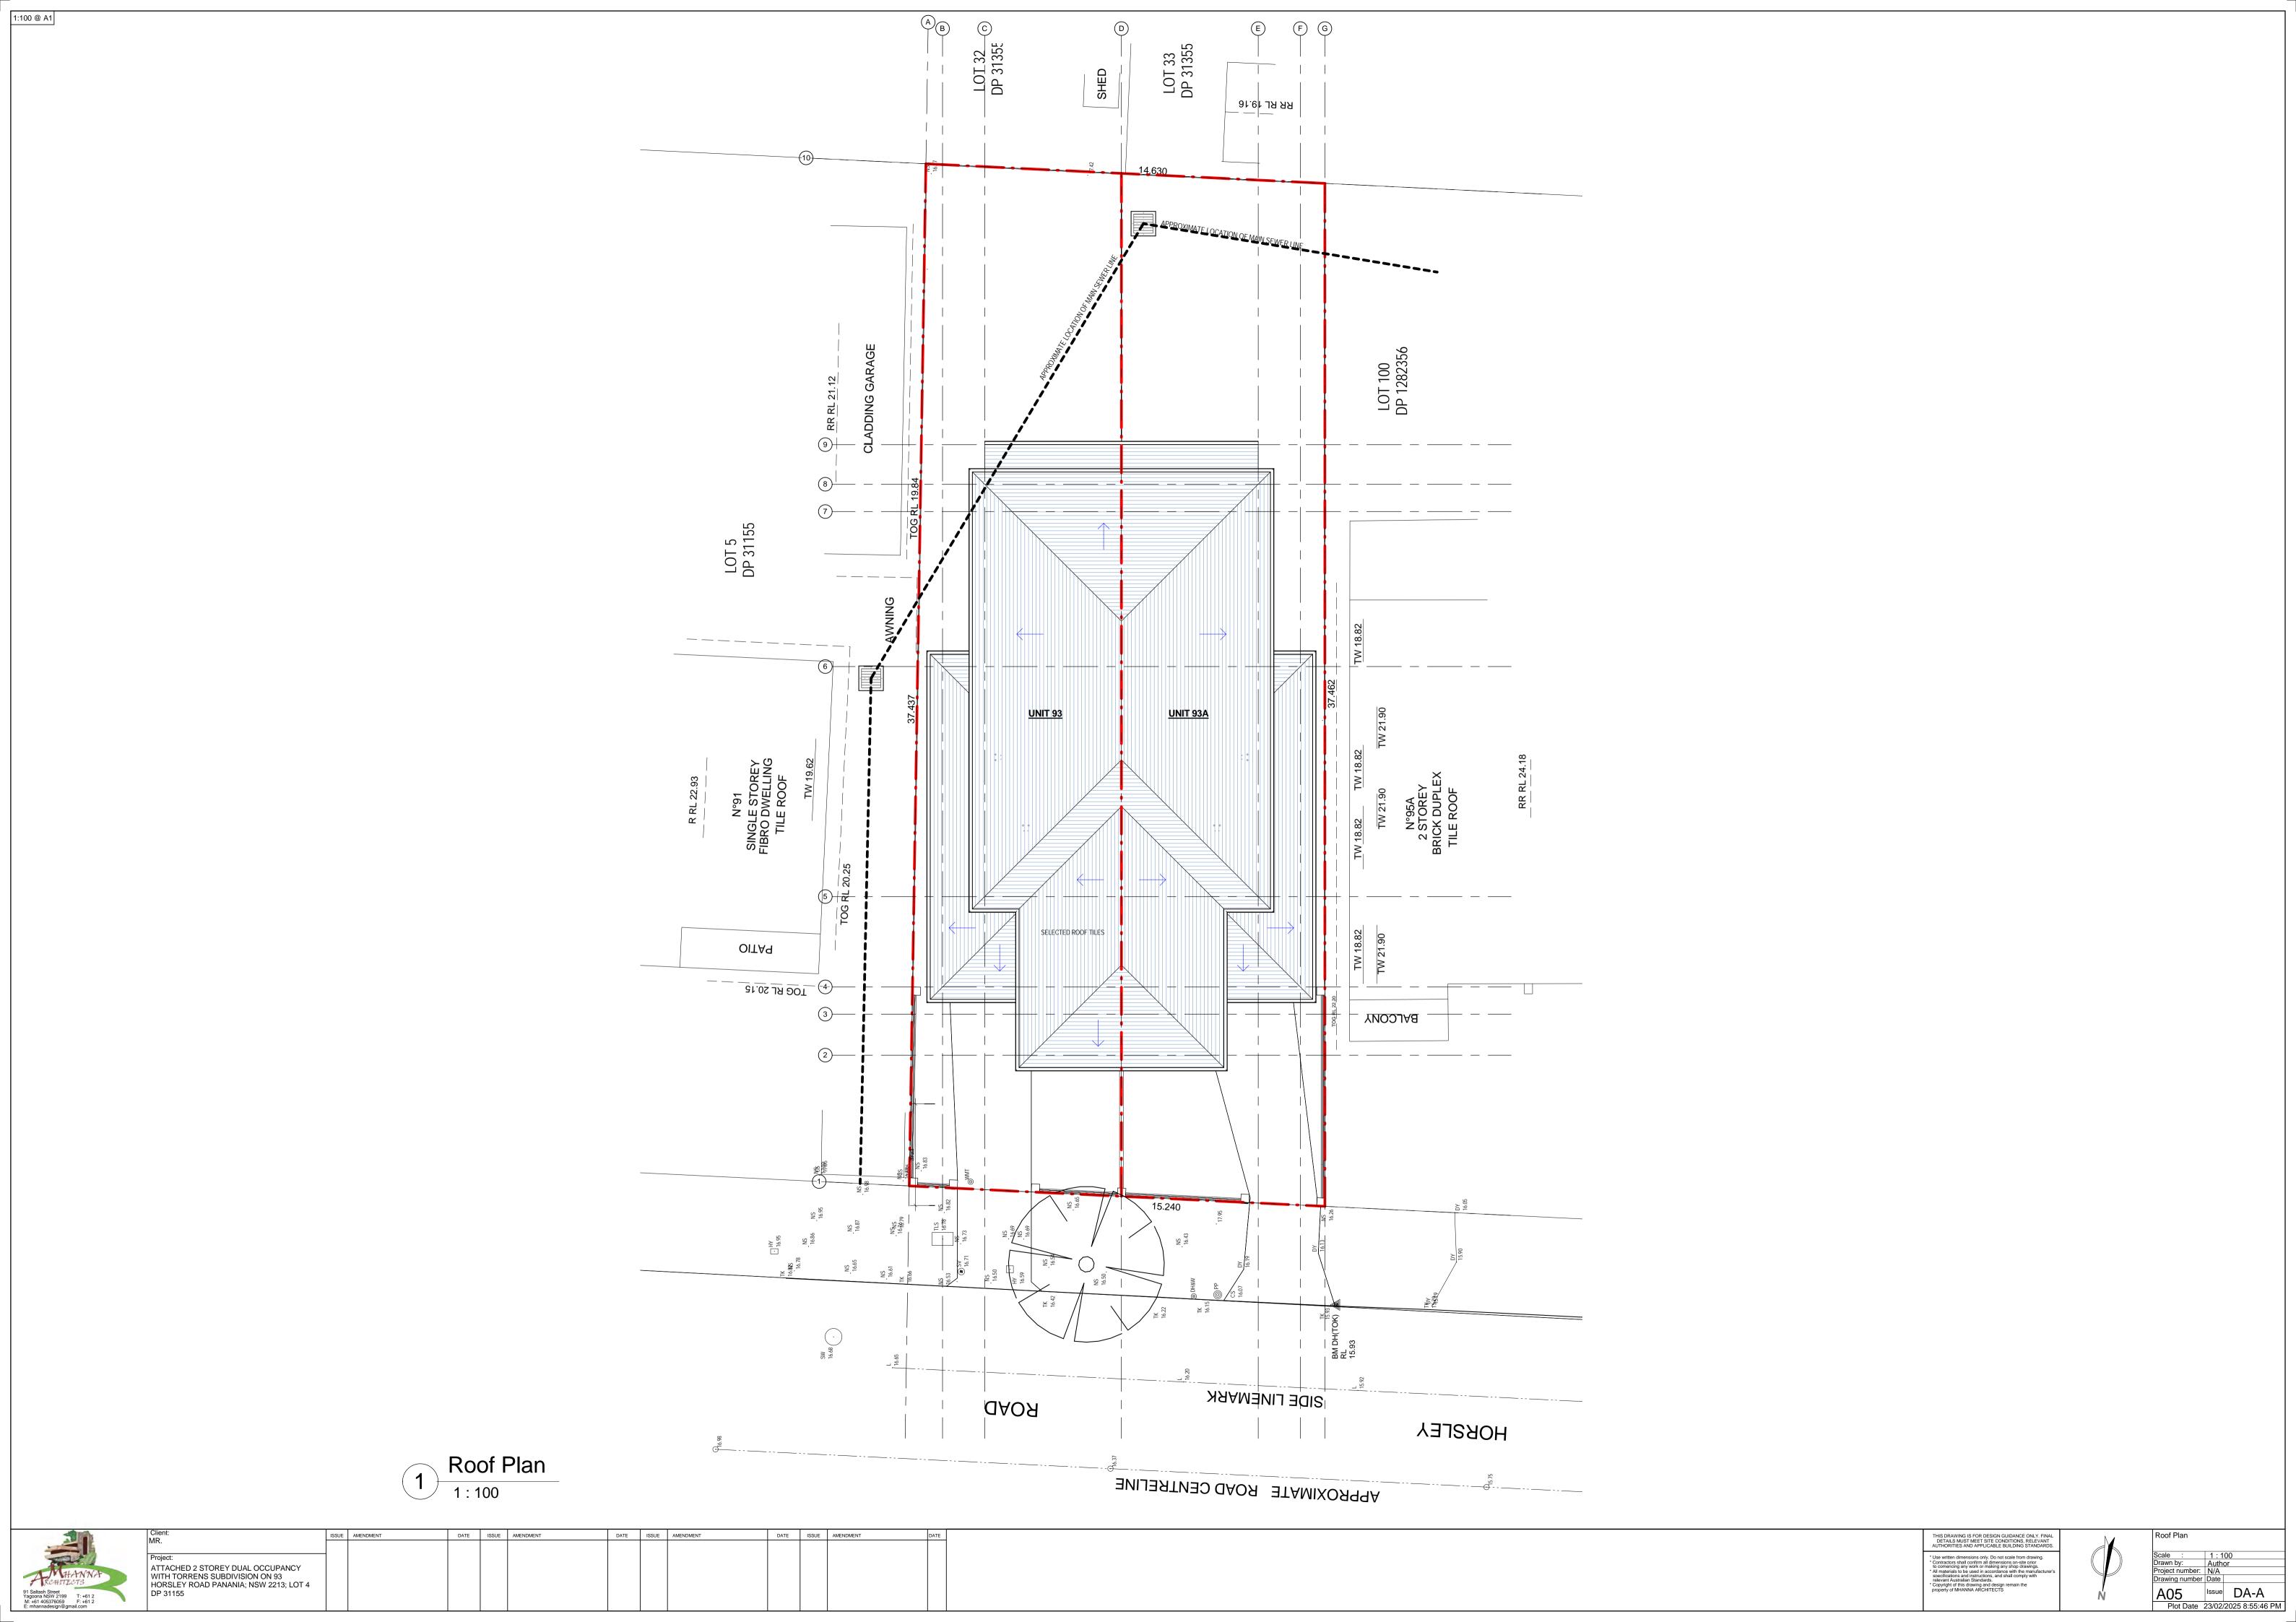

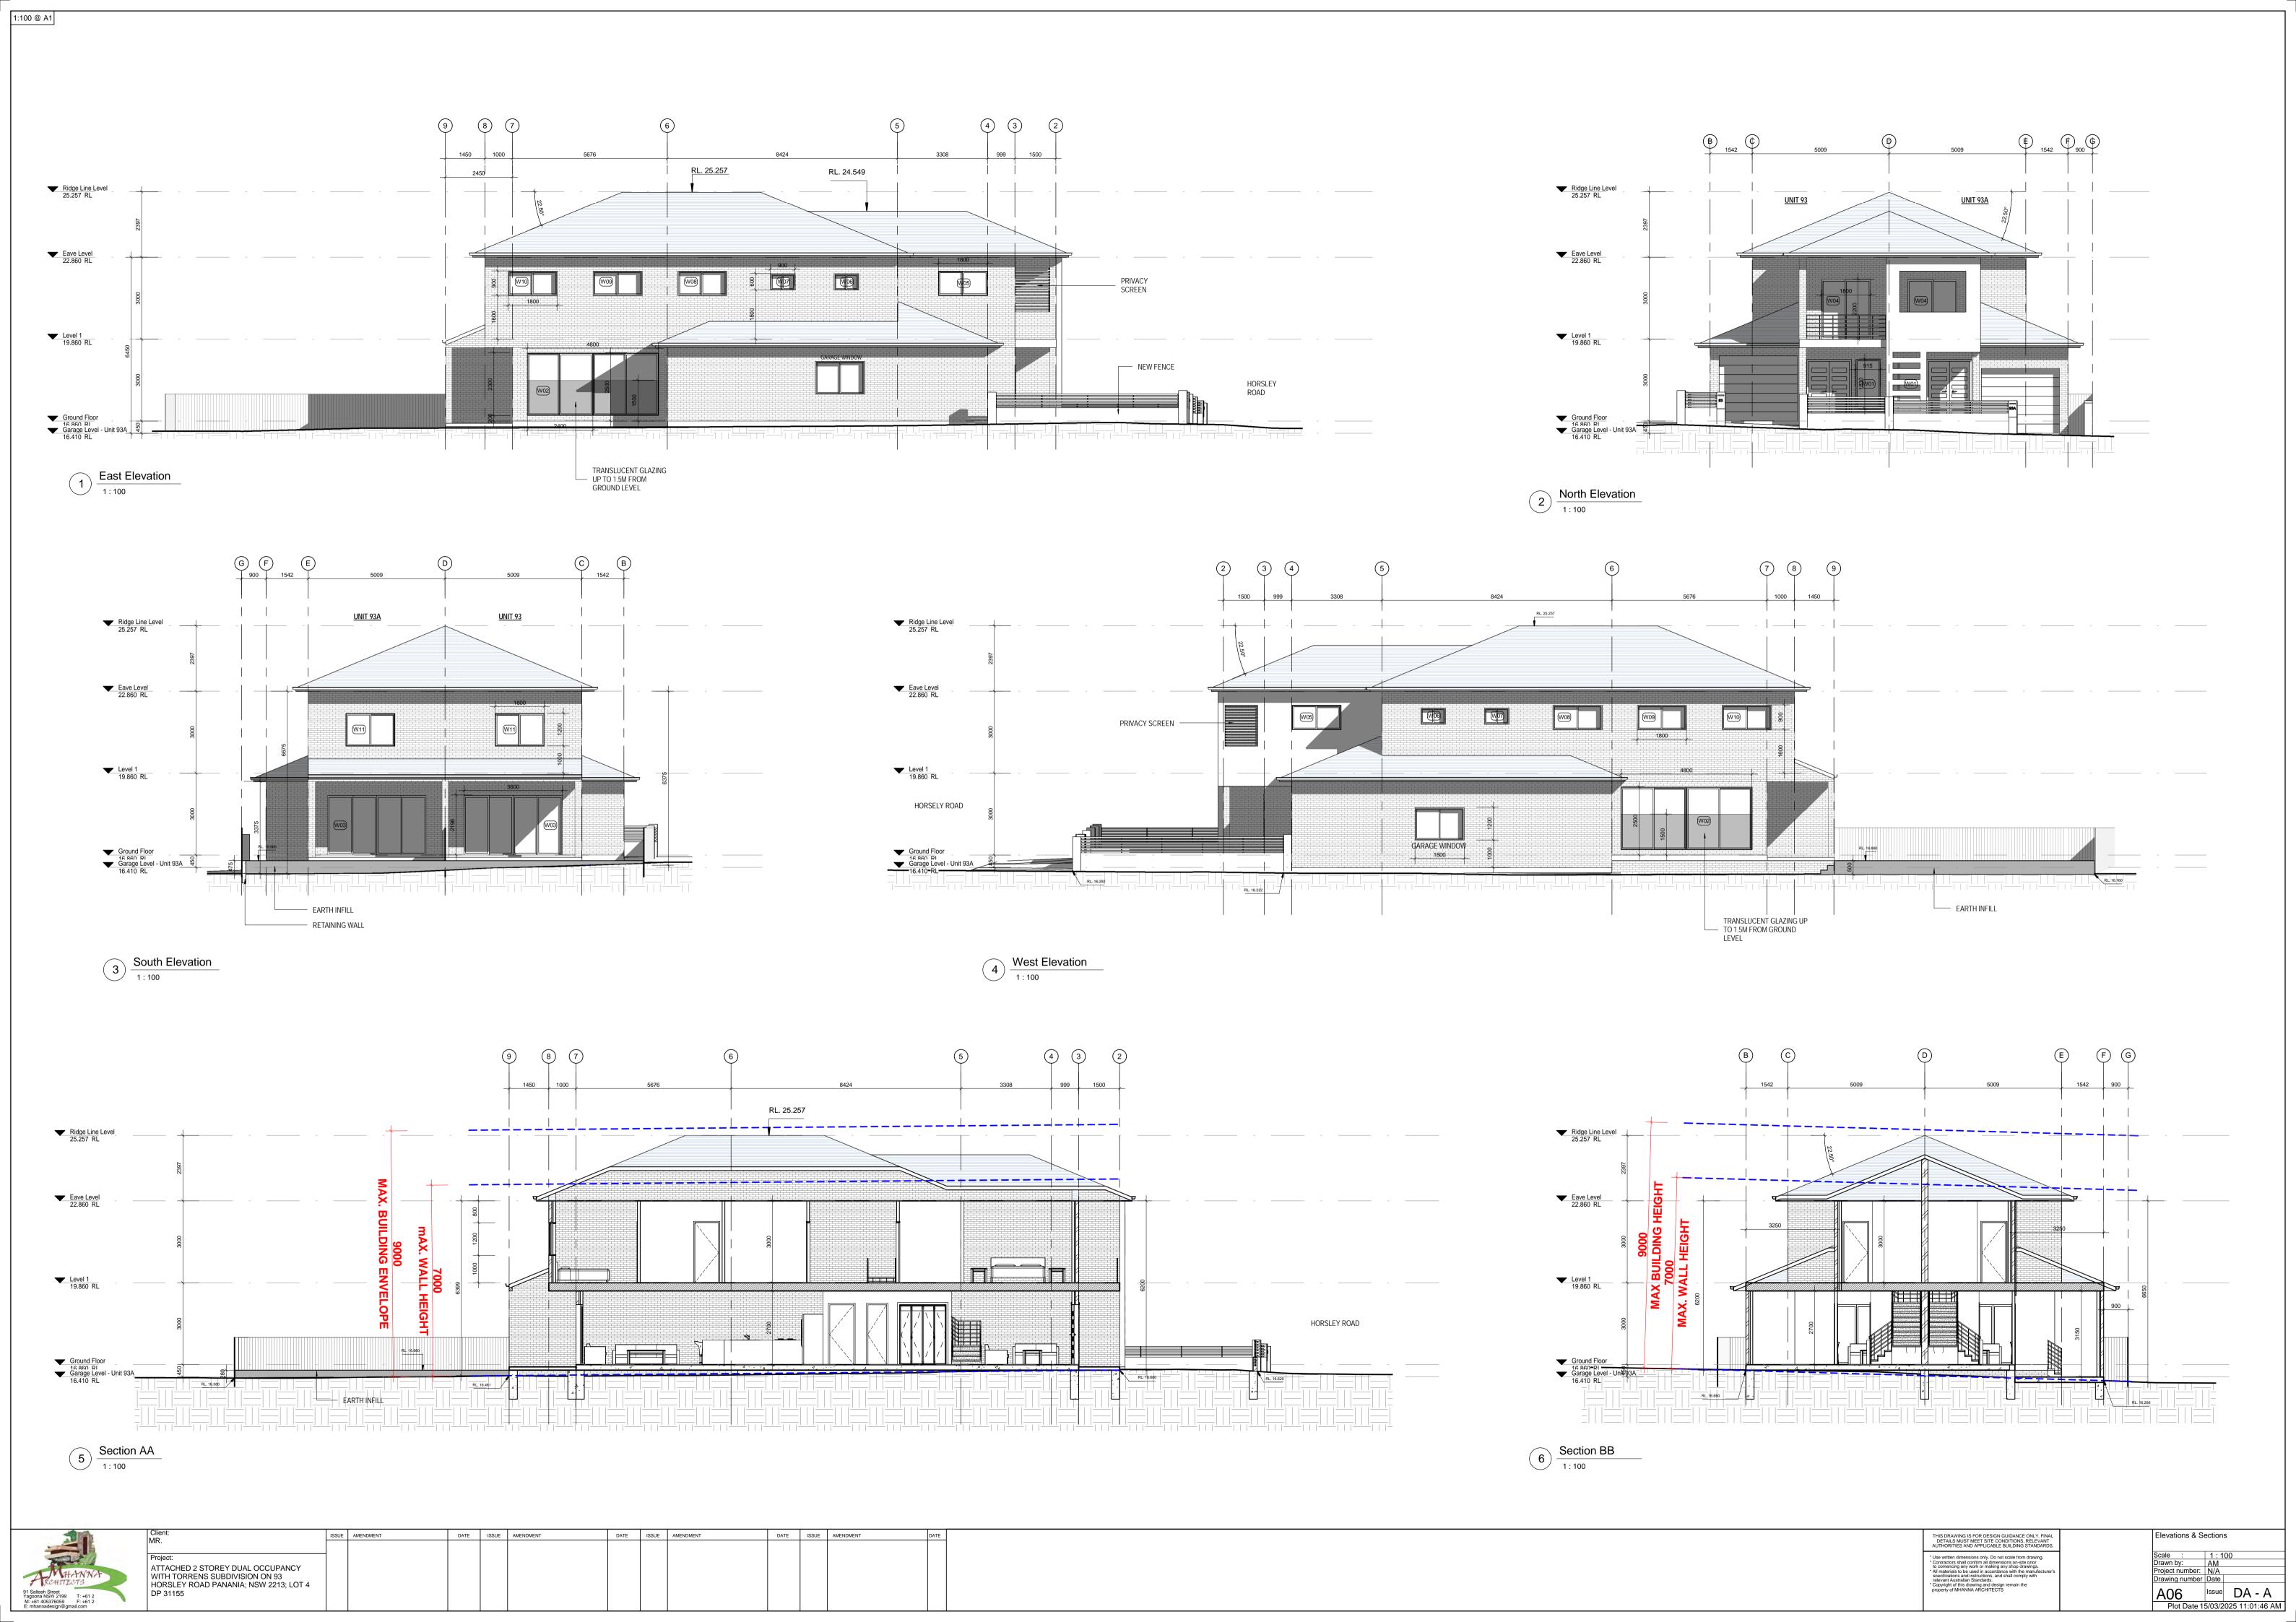

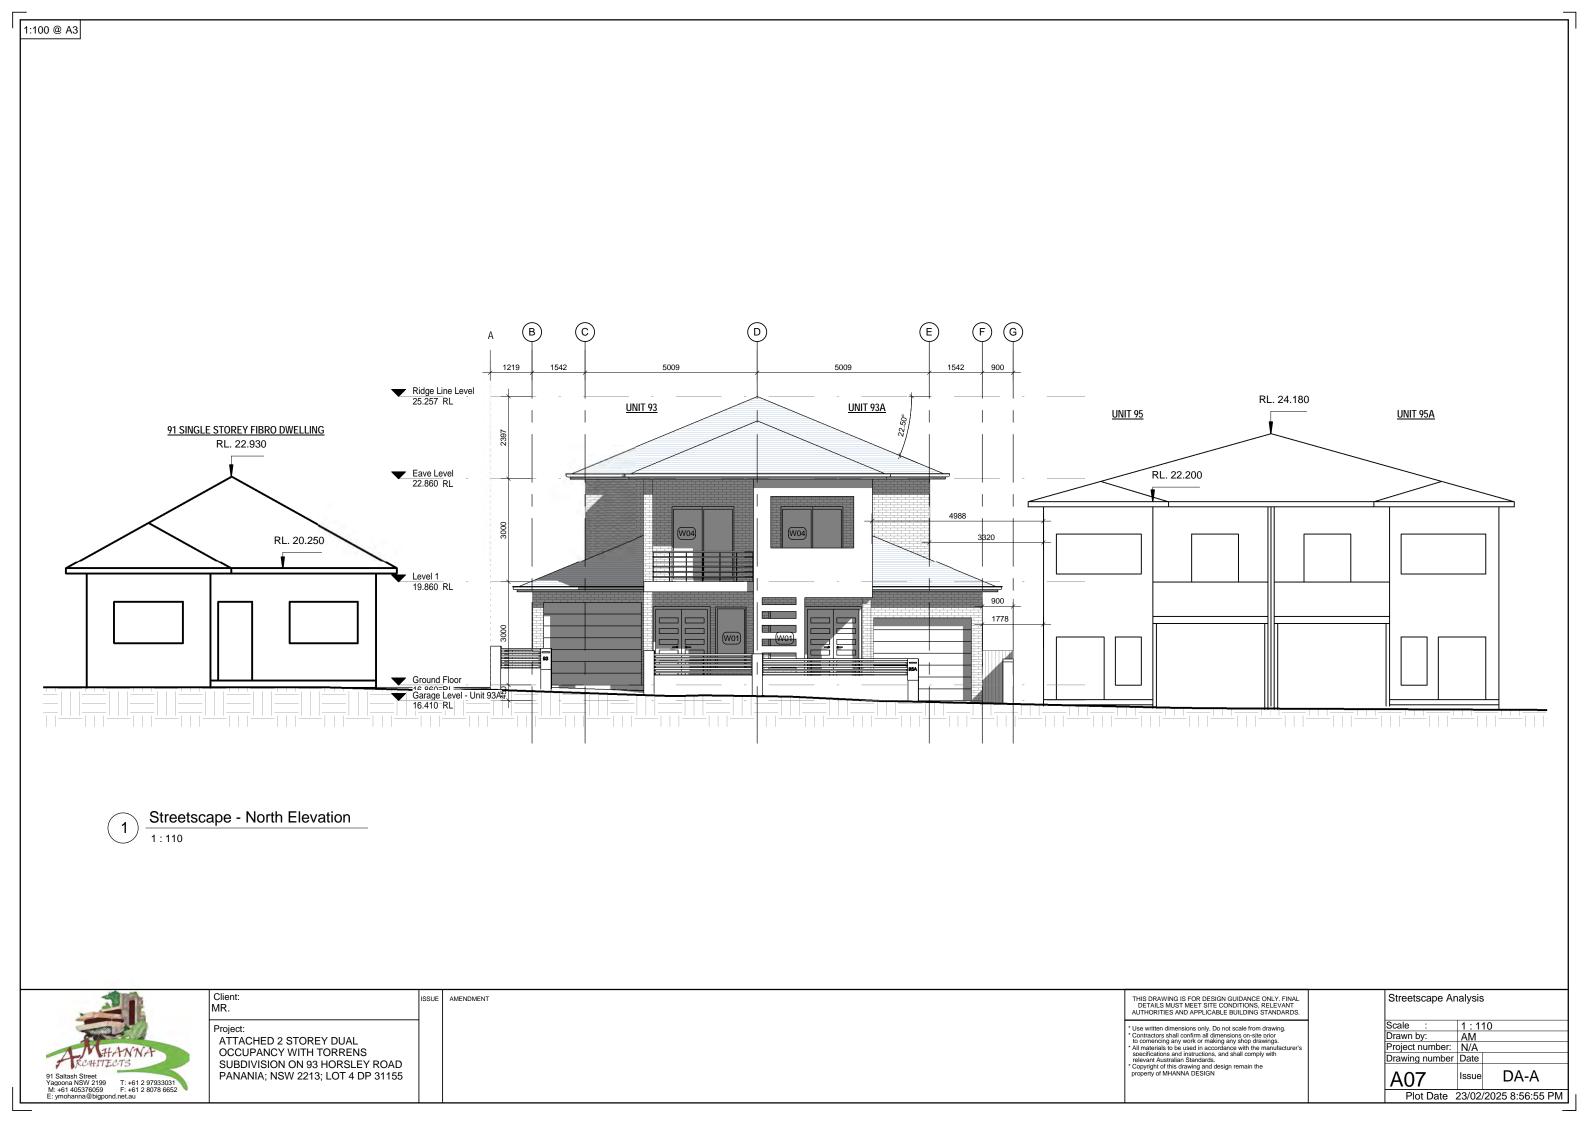

1:100 @ A3 **PROPOSED** PROPOSED SILT FENCE SILT FENCE REFER TO **REFER TO DETAIL DETAIL UNIT 93 UNIT 93A PROPOSED** SILT FENCE REFER TO **DETAIL** RECYCLING STOCK PILE BIN **PROPOSED** WASTE SILT FENCE BIN REFER TO DETAIL **Erosion Sediment Plan** 1:200

SEDIMENT CONTROL NOTES:

- 1. ALL EROSION AND SEDIMENTATION CONTROL MEASURES, INCLUDING REVEGETATION AND STORAGE OF SOIL, SHALL BE IMPLEMENTED TO THE STANDARDS OF THE SOIL CONSERVATION OF N.S.W.
 2. ALL DRAINAGE WORKS SHALL BE CONSTRUCTED AND STABILIZED AS EARLY AS POSSIBLE DURING DEVELOPMENT.

 3. SEDIMENT STRAPS SHALL BE CONSTRUCTED AROUND ALL INLET PITS, CONSIDERING OF SOME MEDICAL PROPERTY.

 2. SEDIMENT STRAPS SHALL BE CONSTRUCTED AROUND ALL INLET PITS, CONSIDERING OF SOME MEDICAL PROPERTY.

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 3. SEDIMENT STRAPS SHALL BE CONSTRUCTED AROUND ALL INLET PITS, CONSIDERING OF SOME PROPERTY.

 3. SEDIMENT STRAPS SHALL BE CONSTRUCTED AROUND ALL INLET PITS, CONSIDERING STRAND.
- CONSISTING OF 300mm WIDE x 300mm DEEP TRENCH.


 4. ALL SEDIMENT BASINS AND TRAPS SHALL BE CLEARED WHEN THE
- STRUCTURES ARE A MINIMUM OF 60% FULL OF SOIL MATERIALS, INCLUDING THE MAINTENANCE PERIOD.


 5. ALL DISTURBED AREAS SHALL BE REVEGETATED AS SOON AS THE RELEVANT WORKS ARE COMPLETED.
- 6. SOIL AND STOCKPILES SHALL BE LOCATED AWAY FROM DRAINAGE LINES AND AREA WHERE WATER MAY CONCENTRATED.
- FABRIC SHALL BE CONSTRUCTED BY STRETCHING A FILTER FABRICS (PROPEX OR APPROVED EQUIVALENT BETWEEN POSTS AT 3.0M CENTRES. FABRIC SHALL BE BURIED 150 mm ALONG LOWER EDGE.


EROSION CONTROL NOTES:


- ALL EROSION AND SILTATION CONTROL DEVICES ARE TO BE PLACED PRIOR TO THE COMMENCEMENT OF ANY CONSTRUCTION WORKS, AND ALL SILT TRAPS ARE TO HAVE DEPOSITED SILT REMOVED REGULARLY DURING CONSTRUCTION.
- 2. ALL TREES ARE TO BE PRESERVED UNLESS INDICATED OTHERWISE ON THE ARCHITECTURAL OR LANDSCAPE DRAWINGS.
 EXISTING GRASS COVER SHALL BE MAINTAINED EXCEPT IN AREAS CLEARED FOR BUILDING, PAVEMENTS ETC.
- 3. INSTALL TEMPORARY SEDIMENT BARRIERS TO ALL INLET PITS LIKELY TO COLLECT SILT LADDEN WATER, TO COUNCIL'S STANDARDS.

 4. NOT WITHSTANDING DETAILS SHOWN IT IS THE CONTRACTORS SOLE RESPONSIBILITY TO ENSURE THAT ALL SITE ACTIVITIES COMPLY WITH THE REQUIREMENTS OF THE CLEAN WATERS ACT.

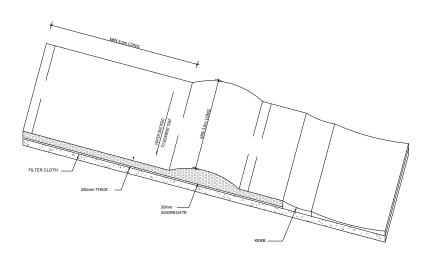

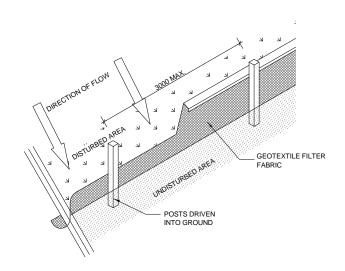

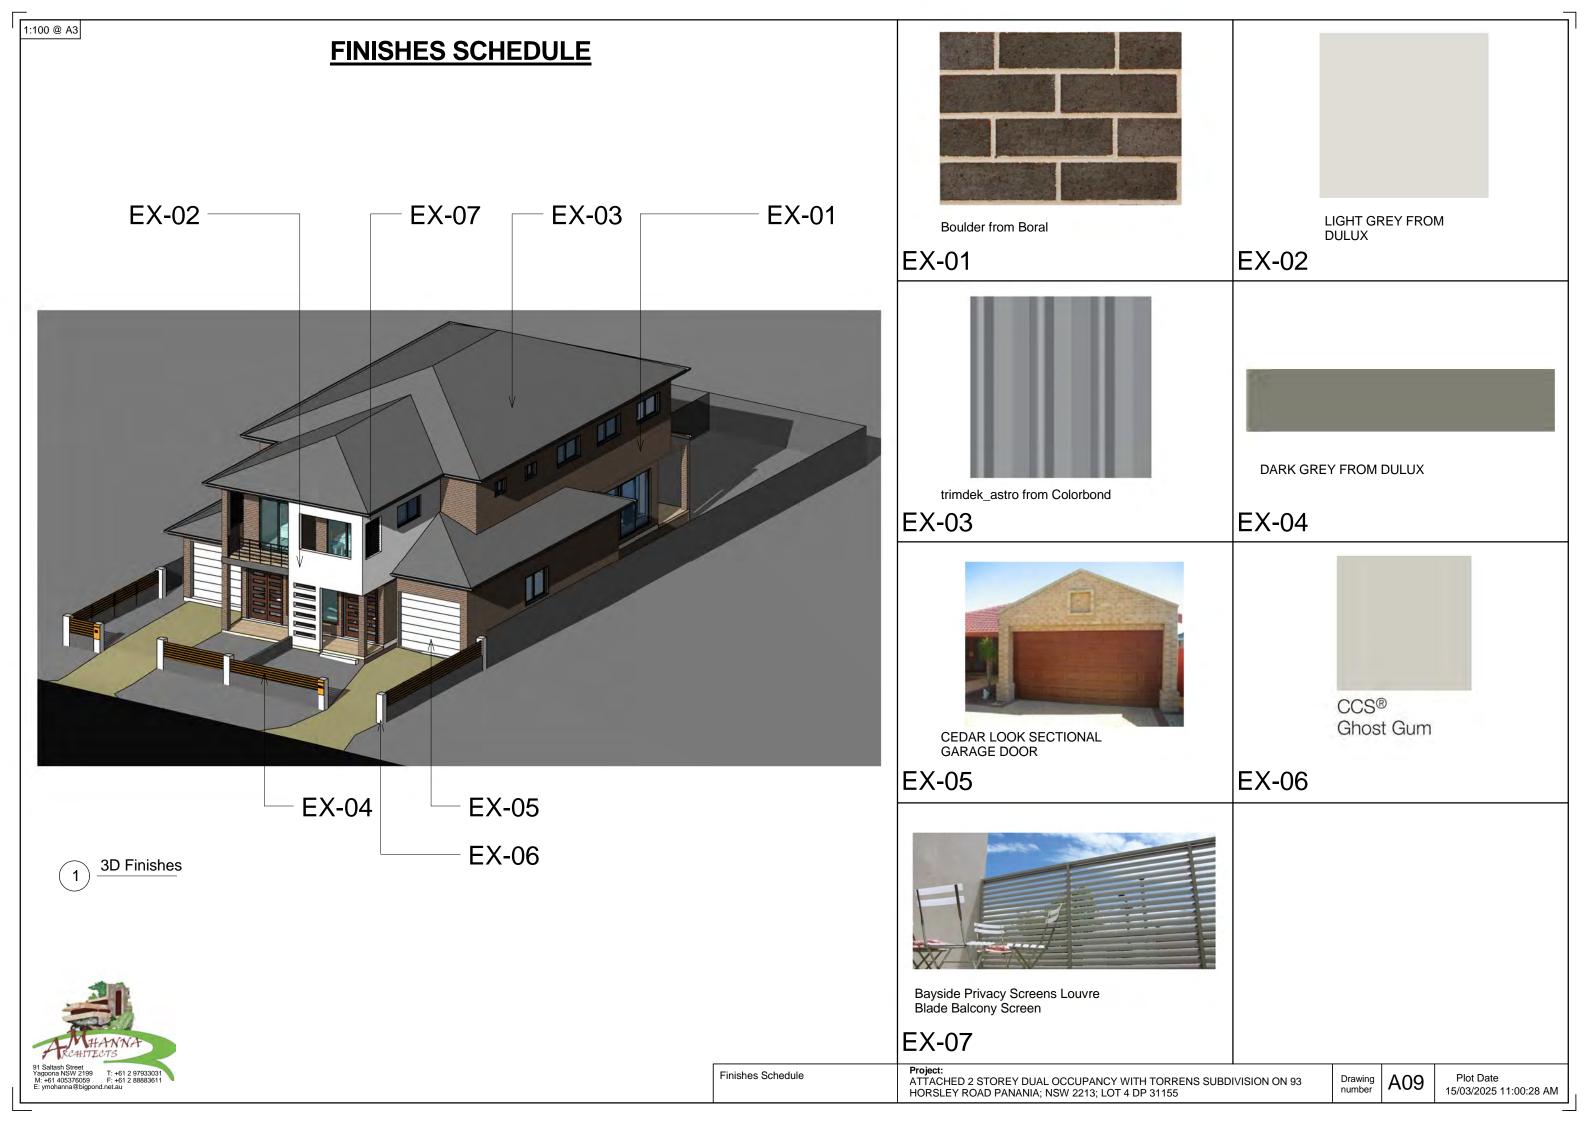

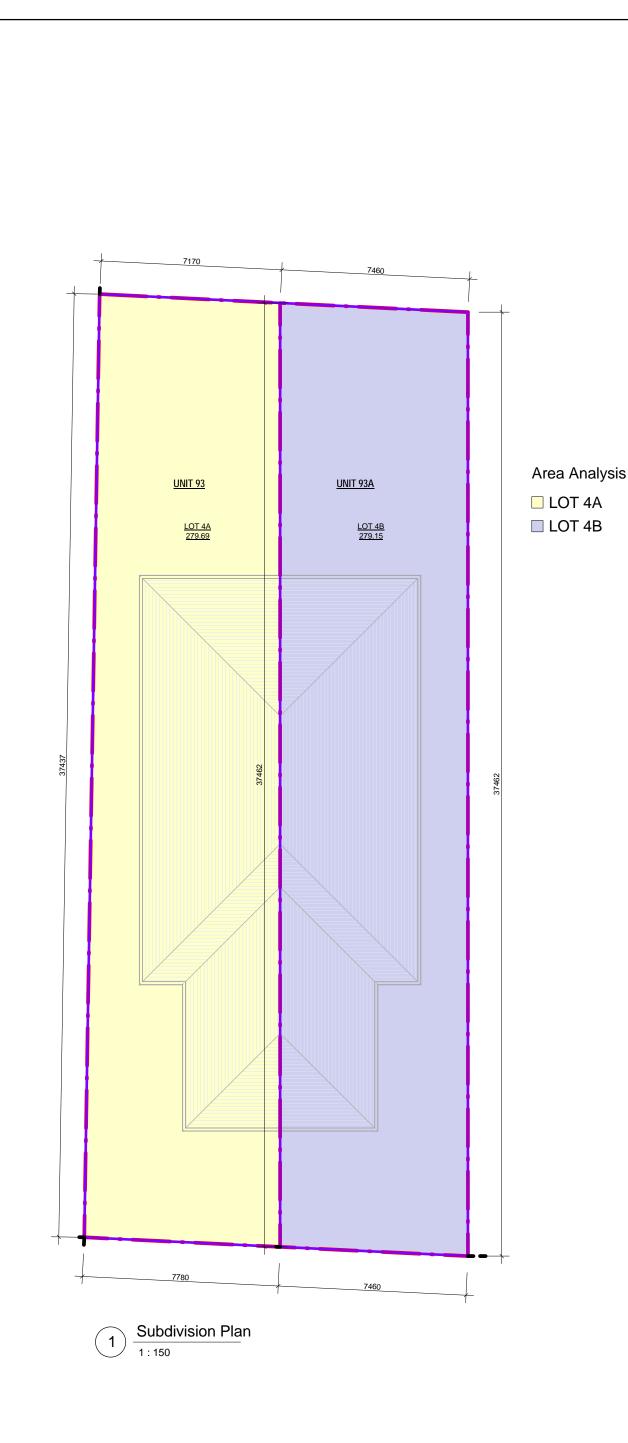

Client:

MR.

ATTACHED 2 STOREY DUAL OCCUPANCY WITH TORRENS SUBDIVISION ON 93 HORSLEY ROAD PANANIA; NSW 2213; LOT 4 DP 31155



Subdivision Plan

Scale : As indicated
Drawn by: AM
Project number: N/A Drawing number Date DA - A Issue

A10

Plot Date 23/02/2025 8:57:52 PM

SUBDIVISION DATA

CURRENT LOT DECSRIPTION:

- STREET ADDRESS: 93 HORSELY ROAD; PANANIA; NSW 2213 - LOT: 4

- SEC: N/A - DP: 31155 - AREA: **558.80 SQM** - TITLE: TORRENS

PROPOSED LOT DESCRIPTION:

-LOT 4A = 279.69 SQM

-LOT 4B = 279.15 SQM

TITLE: TORRENS

TOTAL LAND AREA = 558.8 SQM


50% = 279.40m2

Proposed: <u>279m2 = 50% FSR</u>


ALL DIMENSIONS & LAND AREAS DEPICTED IN THIS SUBDIVISION PLAN TO BE CHECKED & VARIFIED BY REGISTERED SURVEYOR WITH LODGEMENT OF LINEN PLAN TO LAND TITLES OFFICE.





EA @ 001:1

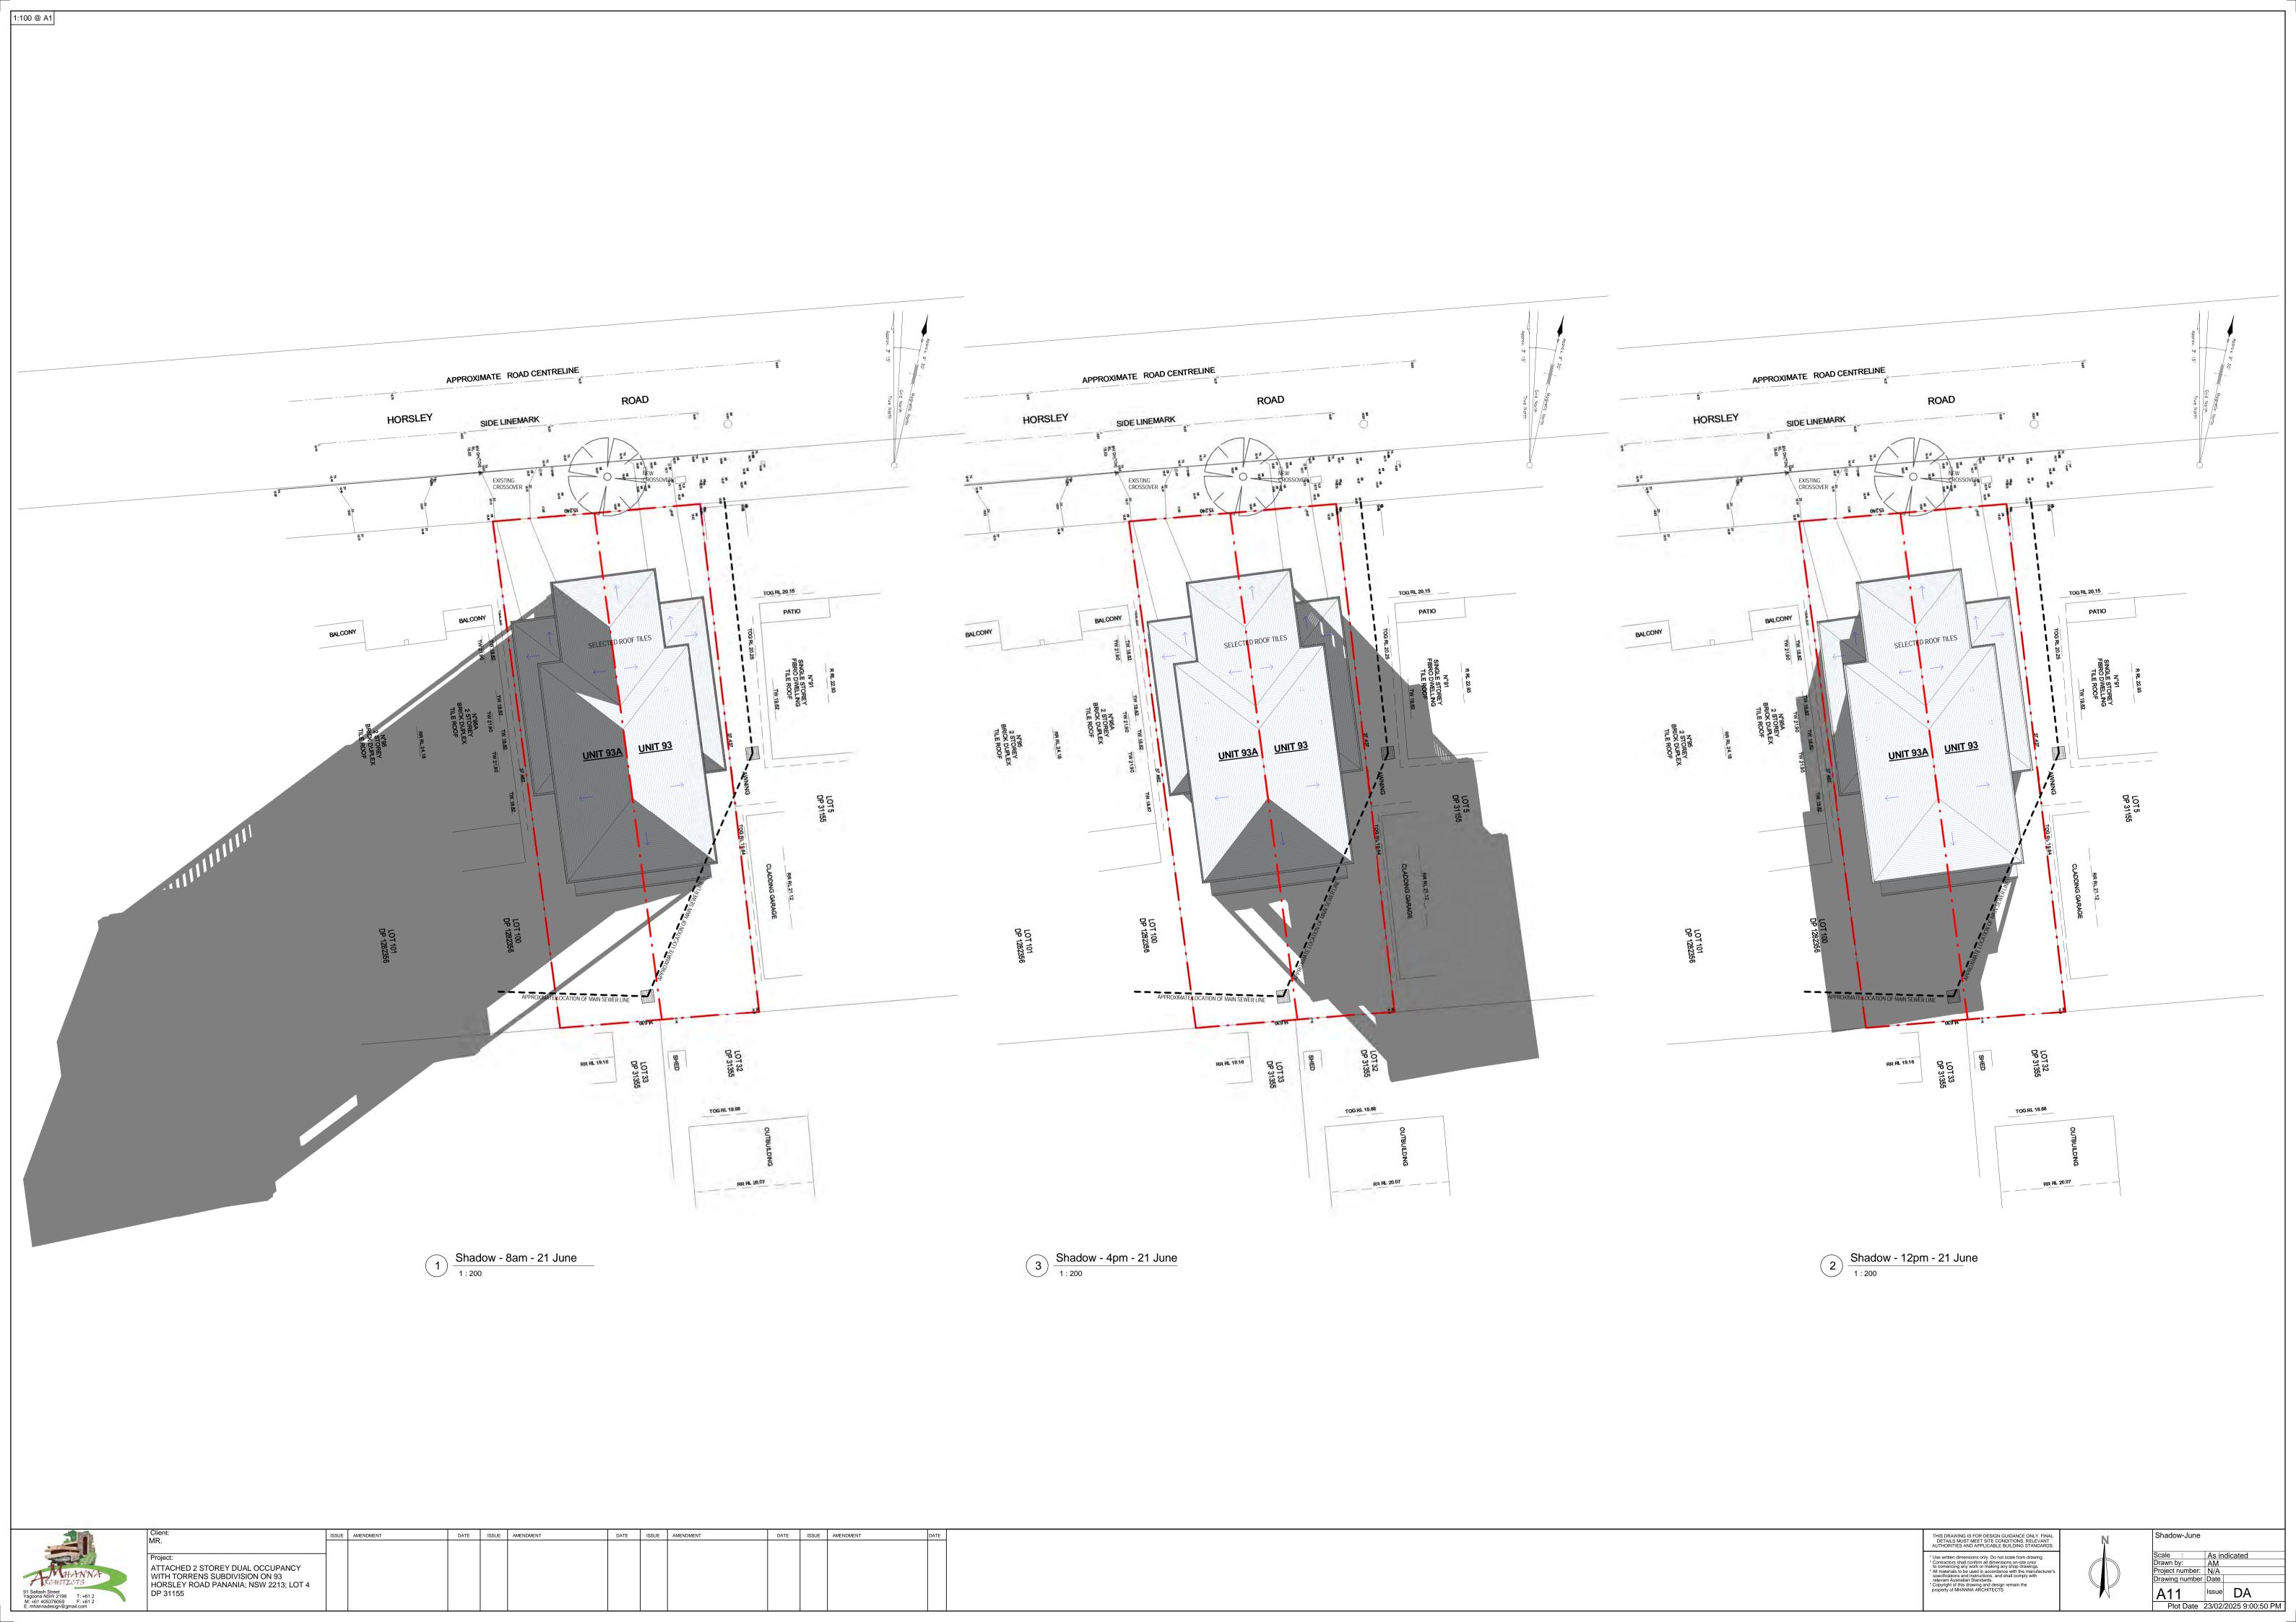




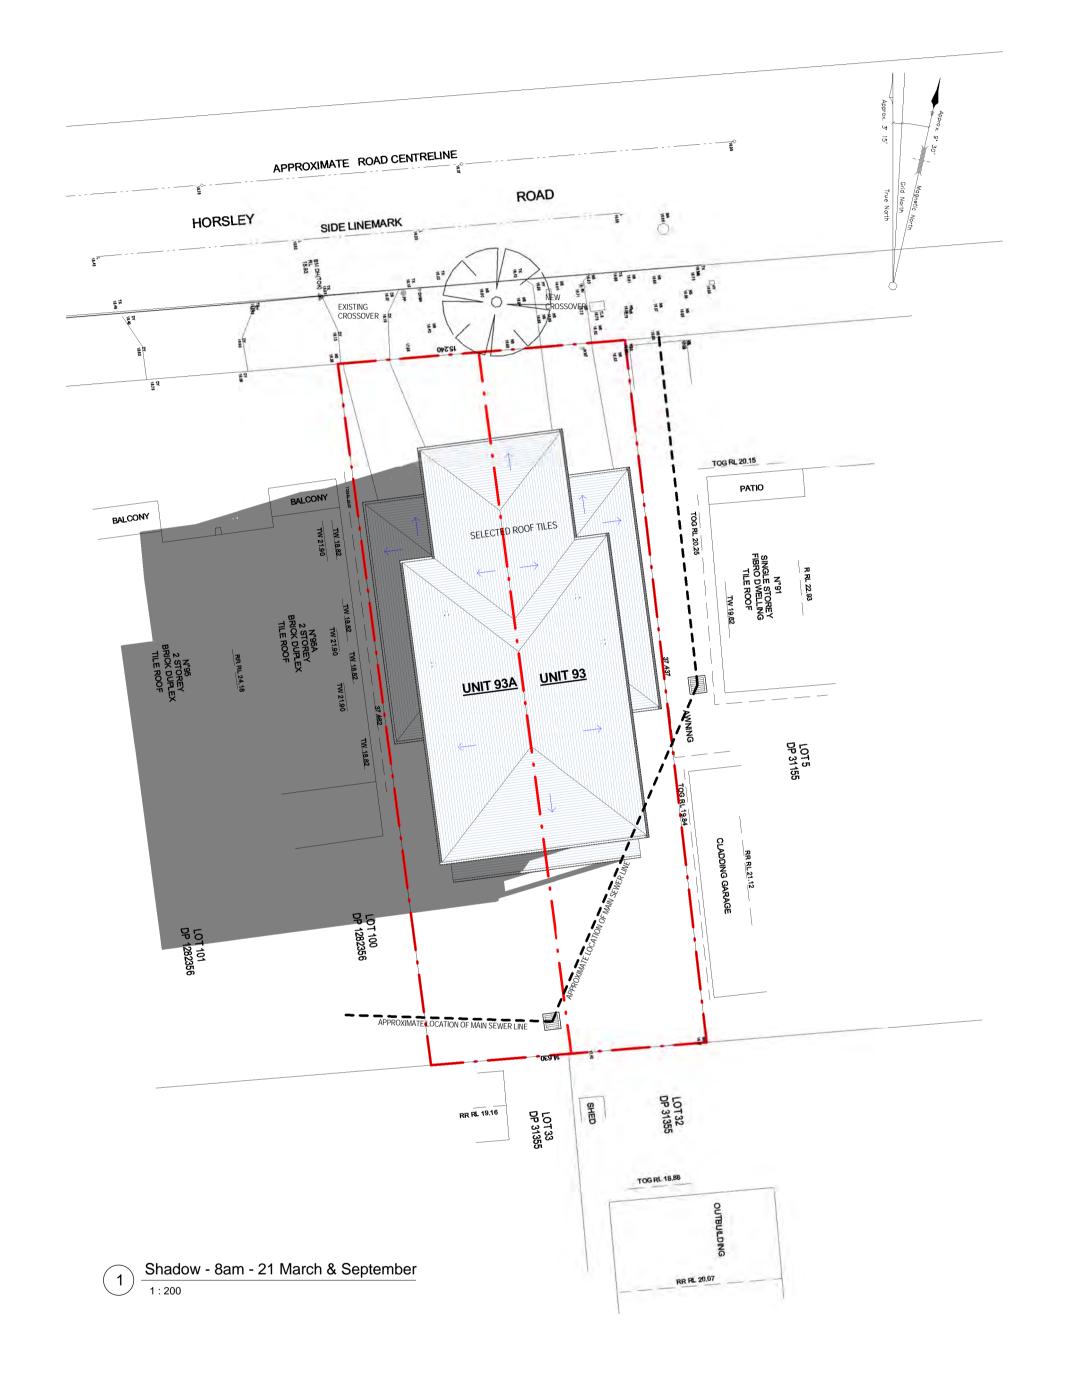

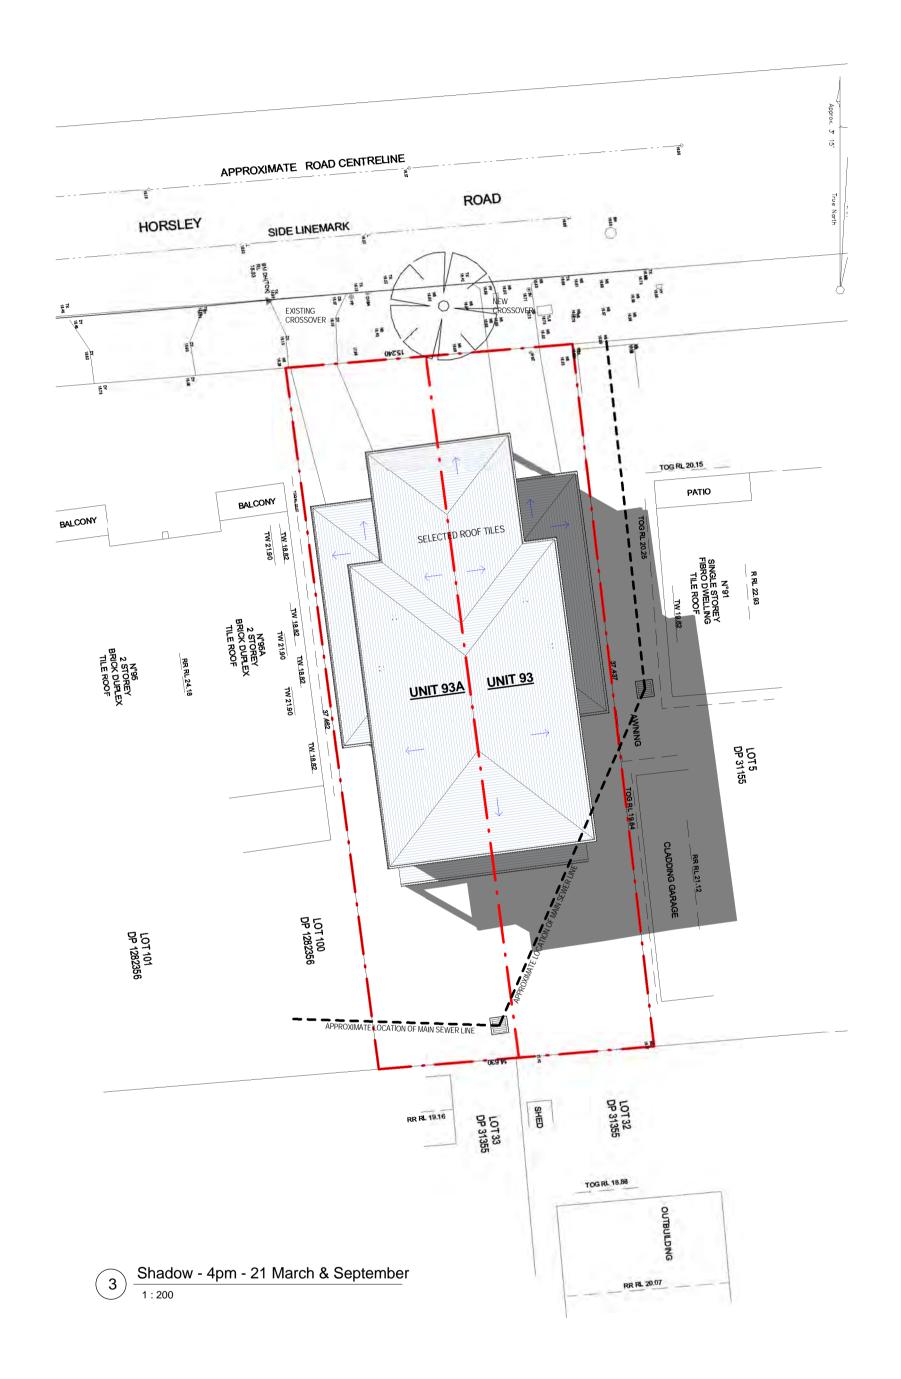


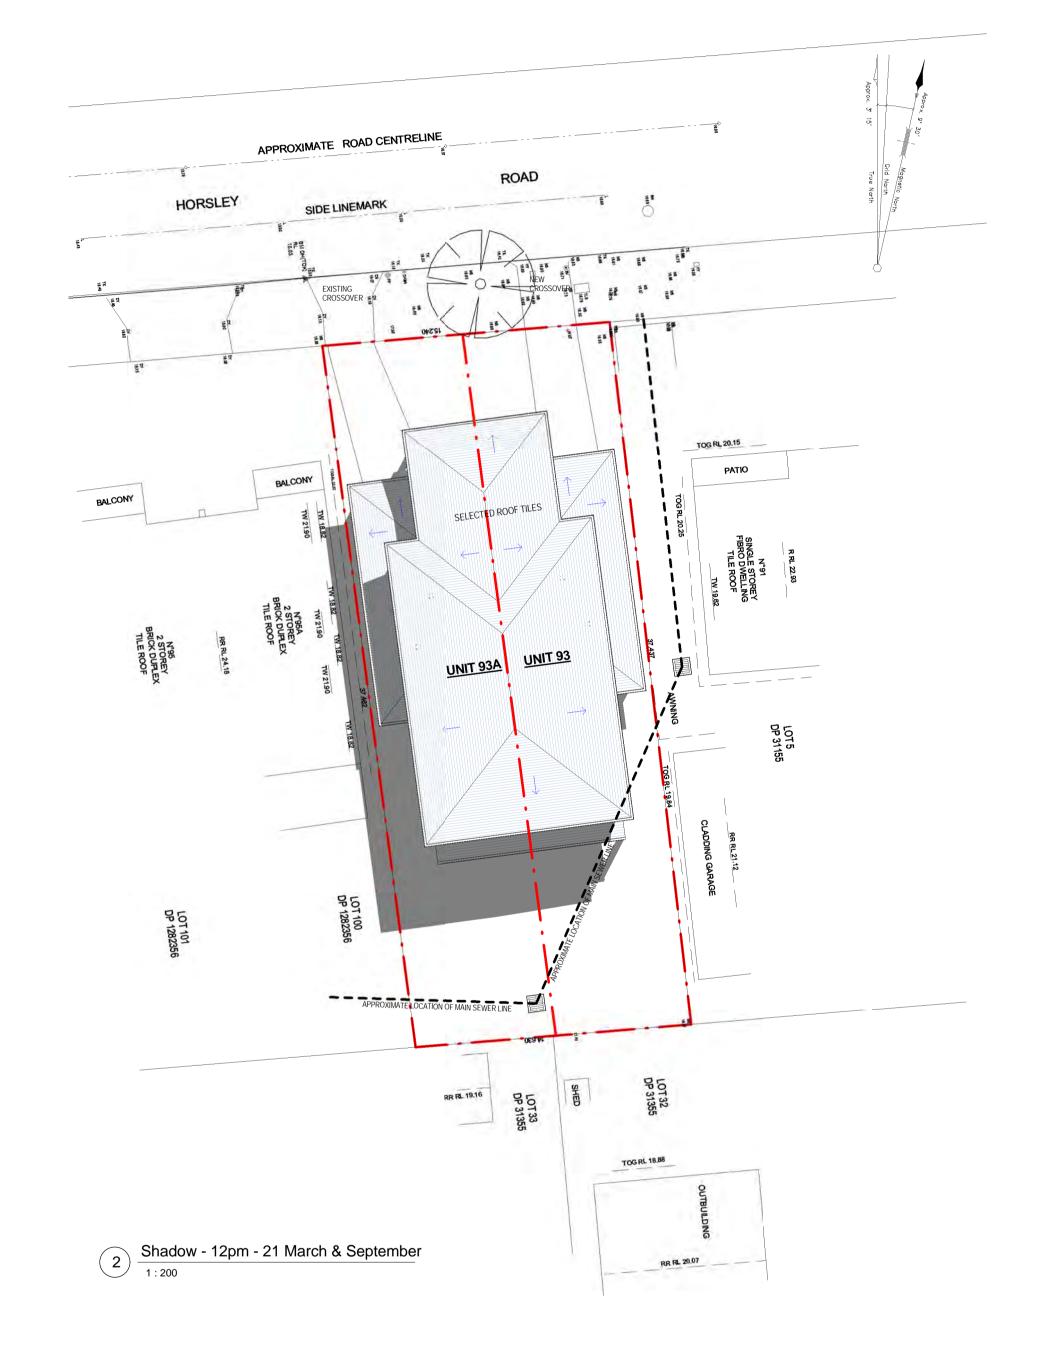



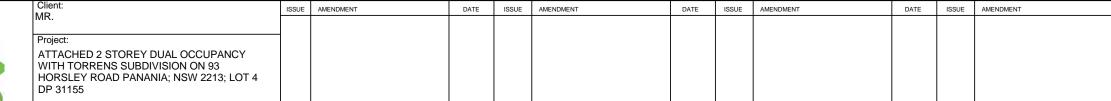



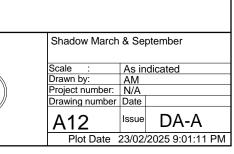







3D View 1 - Corner

Project: ATTACHED 2 STOREY DUAL OCCUPANCY WITH TORRENS SUBDIVISION ON 93 HORSLEY ROAD PANANIA; NSW 2213; LOT 4 DP 31155		lient:	ISSUE	AMENDMENT	DATE	ISSUE	AMENDMENT	DATE	ISSUE	AMENDMENT	DATE	ISSUE	AMENDMENT
M: +61 4U53 70U99 F: +61 Z F F F F F F F F F F F F F F F F F F	91 Saltash Street Yagoona NSW 2199 M: 461 405376059 F: 461 2	R. roject: .TTACHED 2 STOREY DUAL OCCUPANCY VITH TORRENS SUBDIVISION ON 93 IORSLEY ROAD PANANIA; NSW 2213; LOT 4											

THIS DRAWING IS FOR DESIGN GUIDANCE ONLY. FINAL DETAILS MUST MEET SITE CONDITIONS, RELEVANT AUTHORITIES AND APPLICABLE BUILDING STANDARDS.	
Use written dimensions only. Do not scale from drawing. Contractors shall confirm all dimensions on-site prior to comencing any work or making any shop drawings. All materials to be used in accordance with the manufacturer's soedifications and instructions, and shall comply with Copyright of this drawing and design remain the property of MHANNA ARCHITECTS	

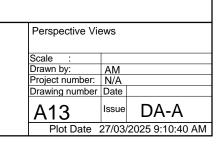

1:100 @ A3

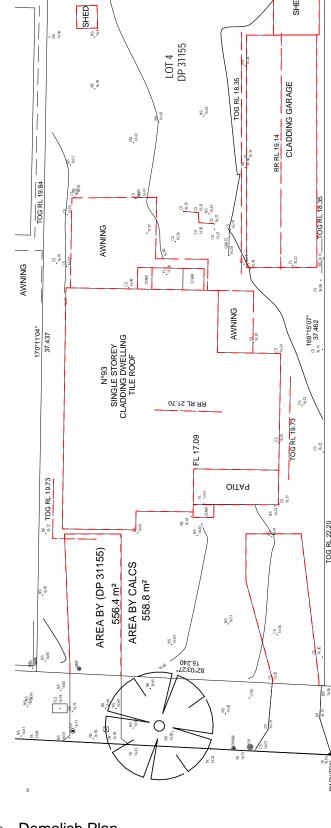

262°03'27" \$\vec{2} \vec{2} \v

NS 16.43





Demolish Plan


1:200







DEMOLISHING WORK

Solar Access Study - Living Room 1 - Unit 93

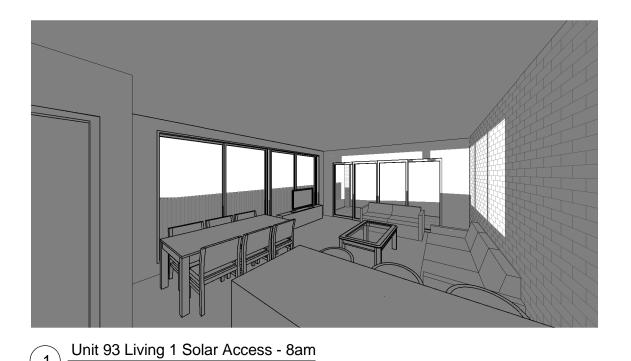


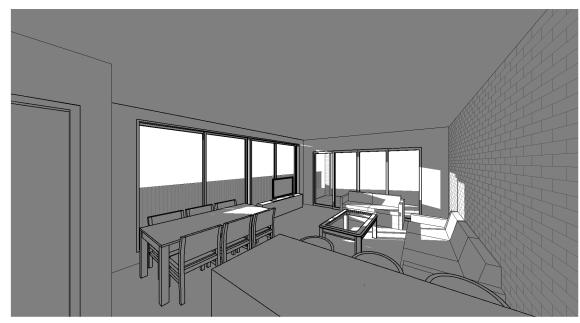

Unit 93 Living 1 Solar Access - 9am

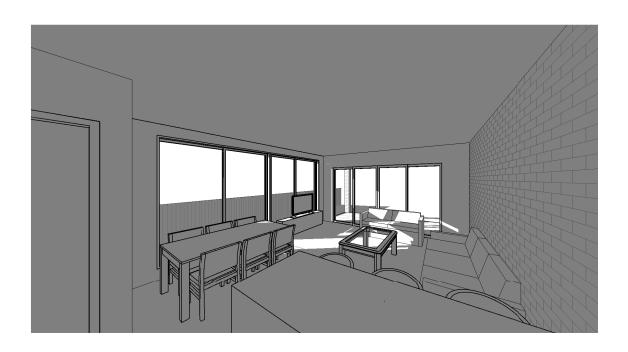


(3) Unit 93 Living 1 Solar Access - 10am

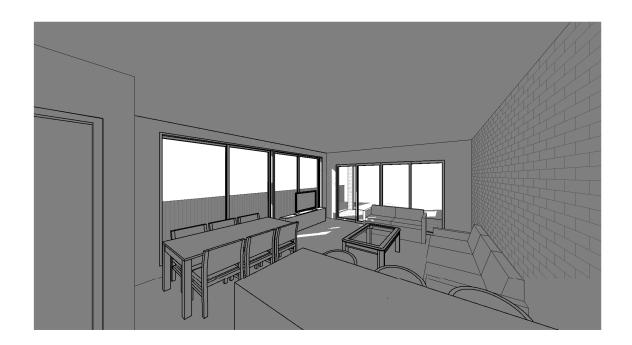


Unit 93 Living 1 Solar Access - 11am




Solar Access Study - Living Room 1 - Unit 93A

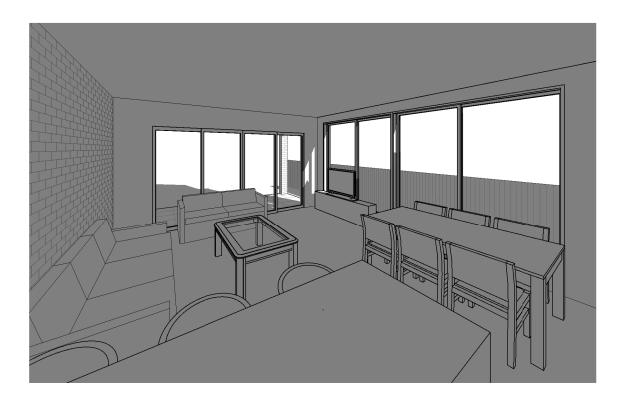


Unit 93A Living 1 Solar Access - 2pm

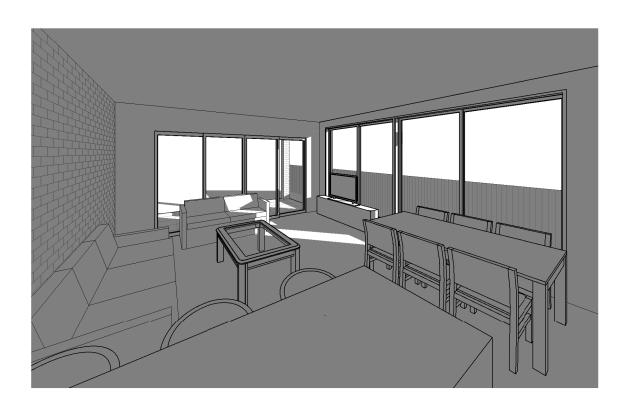

Unit 93A Living 1 Solar Access - 4pm

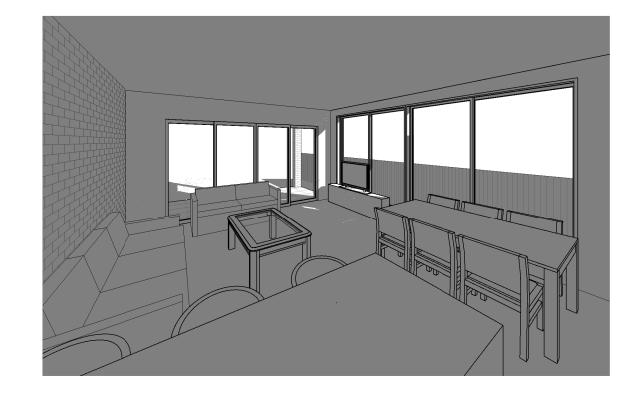

Unit 93A Living 1 Solar Access - 3pm

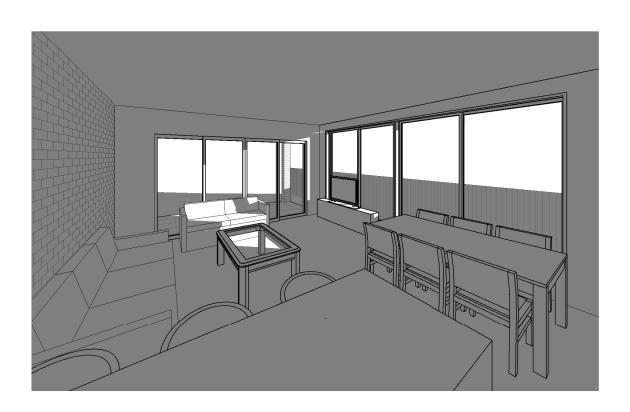


Unit 93A Living 1 Solar Access - 5pm

12/03/2025 9:00:28 PM

Solar Access Study - Living Room 2 - Unit 93A



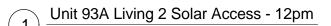




Unit 93A Living 2 Solar Access - 2pm



Unit 93A Living 2 Solar Access - 1pm

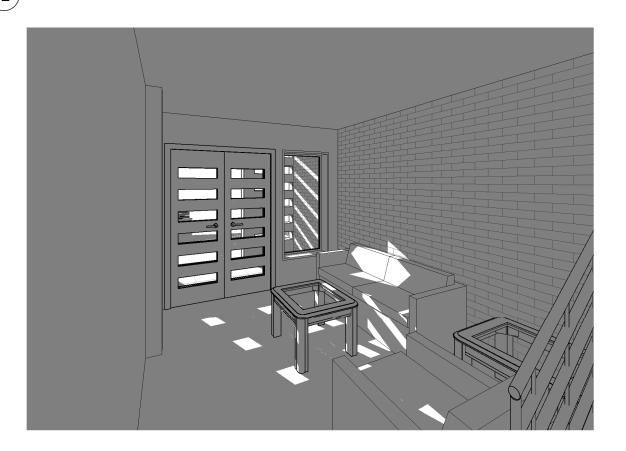

Unit 93A Living 2 Solar Access - 3pm